


Mr & Mrs Phillip PROJECT: TWO STOREY-DUAL OCCUPANCY 21/06/22 L.L.F. G.BOTROS DA SUBMIT L31, 14 Davies Road, Padstow DATE DRAWN CHEKD DESCRIPTION

Structural Civil Engineers

TEL: (02) 9792 4899 FAX: (02) 9792 4899 MOB: 0414 979377 E-MAIL: gbcon@msn.com

_				
	DATE: 17/06/22	SCALE: AS SHOWN		
	DESIGN BY: G-B	CHECKED BY: G-BOTROS		
	DRAWN BY: L.L.F.	APPROVED:		
	SHEET NO. SHEET 1 of 3	DWNG NO. 186/22	REV. A	

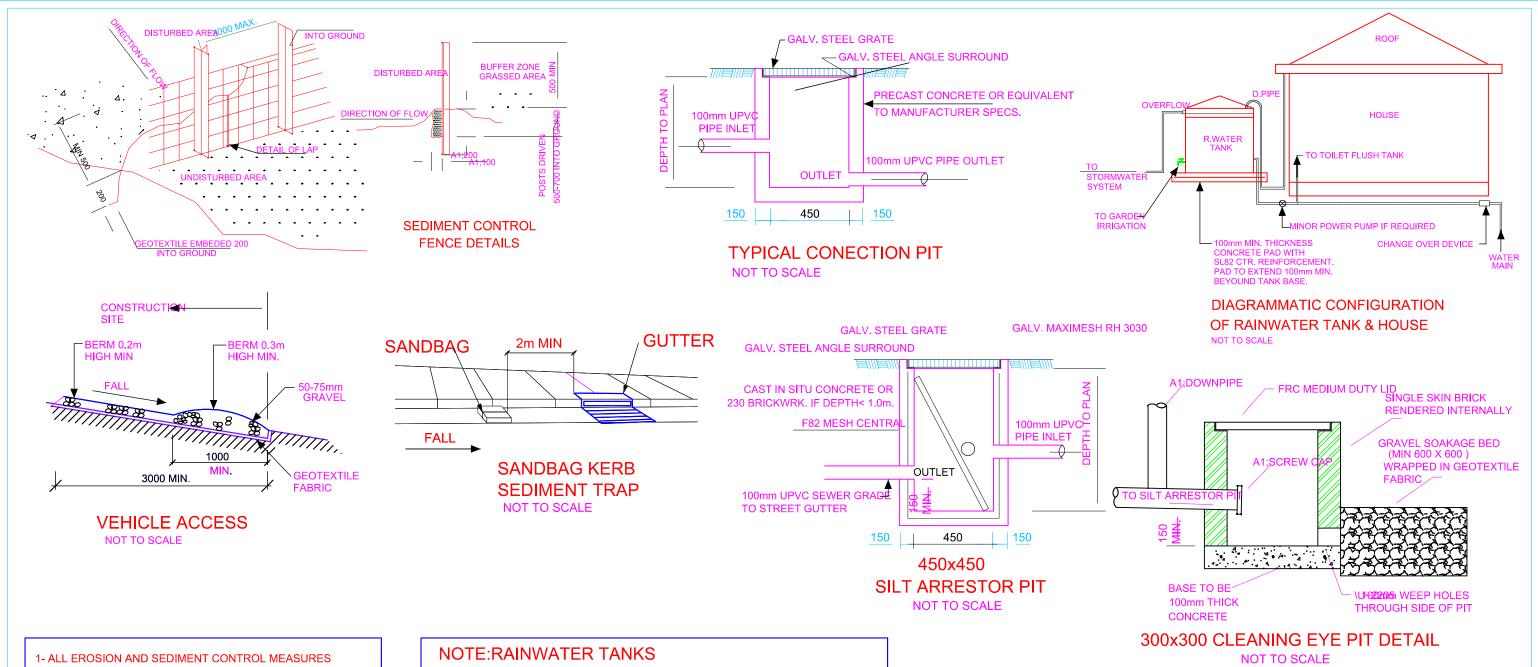

TO BE INSTALLED PRIOR TO SITE DISTURBANCE.

2- STRIPPING OF GRASS AND VEGETATION ETC

FROM SITE SHALL BE KEPT TO A MINIMUM.

3- ALL SEDIMENT CONTROL STRUCTURES TO BE INSPECTED AFTER EACH RAINFALL EVENT FOR STRUCTURAL DAMAGE AND ALL TRAPPED SEDIMENT TO BE REMOVED

TO A NOMINATED STOCKPILE SITE

4- THE BUILDER SHALL NOTIFY ALL SUBCONTRACTORS AND ENSURE COMPLIANCE WITH ALL CONDITIONS OF COUNCIL APPROVAL IN PARTICULAR EROSION AND SEDIMENT CONTROL

1- RAIN WATER TANK CAPACITY AS PER BASIX REQUIREMENTS

P2- THE SYSTEM TO BE DESIGNED WITH THE FOLLOWING GUIDELINES

Pn- A "FIRST FLUSH" DIVERSION TO REMOVE ROOF CONTAMINANTS

PD- ADEQUATE SCREENING TO PREVENT MOSQUITO BREEDING AND DECEMBER 1

□ ENTRY OF ANIMALS OF FOREIGN MATTER

P3- TANKS TO BE PLUMBED TO TOP UP FROM THE POTABLE WATER SUPPLY

DURING DRY PERIODS WHEN THE TANKS ARE 80% EMPTY.

P4- NO DIRECT CROSS CONNECTION WITH THE SYDNEY WATER POTABLE SUPPLY AND AIR GAS MAINTAINED ABOVE THE OVERFLOW IN THE TANK

P5- A SING TO BE INSTALLED STATING "NOT FOR HUMAN CONSUMPTION.

P6- RAINWATER TANK TO BE CONNECTED AS PER BASIX REQUIREMENTS

P7- OVERFLOW FROM THE TANK SHALL BE PIPED TO THE DRAINAGE SYSTEM.

#### **RAINWATER TANKS DATA:**

CAPACITY: REFER TO BASIX QTY: 2 TANKS TYPE: ABOVE GROUND

### TITLE:

## STORMWATER-DRAINAGE PLAN

						CLIENT: Mr & Mrs Phillip
	A	21/06/22	L.L.F.	G.BOTROS	DA SUBMIT	PROJECT: TWO STOREY-DUAL OCCUPANCY
F	REV	DATE	DRAWN	CHEKD	DESCRIPTION	L31, 14 Davies Road, Padstow


# **GHALY BOTROS**

Structural Civil Engineers

242 The River Road Revesby 2212 NSW

TEL: (02) 9792 4899 FAX: (02) 9792 4899 MOB: 0414 979377 E-MAIL: gbcon@msn.com

DATE: 17/06/22	SCALE: AS SHOWN		
DESIGN BY:	CHECKED BY: G-BOTROS		
DRAWN BY: L.L.F.	APPROVED:		
SHEET NO. SHEET 2 of 3	DWNG NO. 186/22	REV. A	

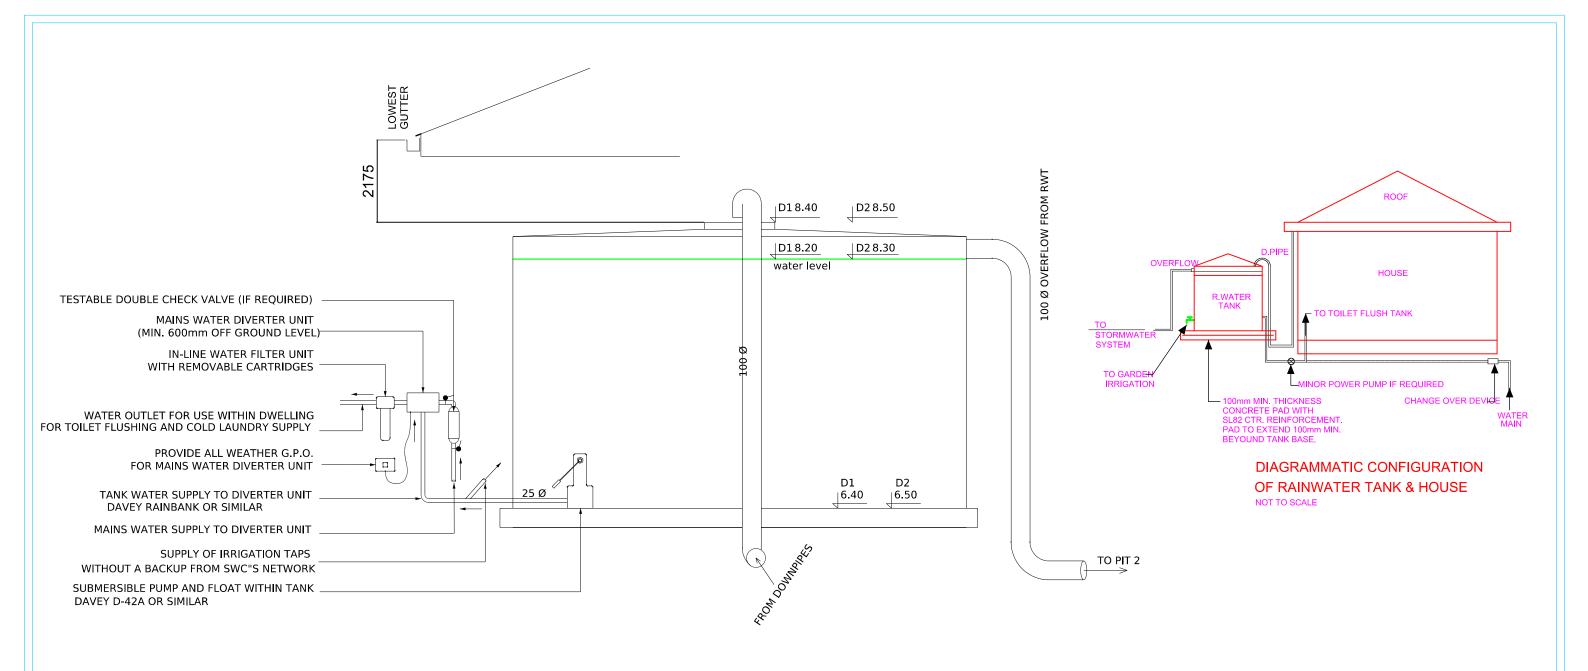

TO BE INSTALLED PRIOR TO SITE DISTURBANCE.
2- STRIPPING OF GRASS AND VEGETATION ETC
FROM SITE SHALL BE KEPT TO A MINIMUM.
3- ALL SEDIMENT CONTROL STRUCTURES TO BE INSPECTED
AFTER EACH RAINFALL EVENT FOR STRUCTURAL DAMAGE
AND ALL TRAPPED SEDIMENT TO BE REMOVED
TO A NOMINATED STOCKPILE SITE
4- THE BUILDER SHALL NOTIFY ALL SUBCONTRACTORS
AND ENSURE COMPLIANCE WITH ALL CONDITIONS OF

COUNCIL APPROVAL IN PARTICULAR EROSION AND

1- ALL EROSION AND SEDIMENT CONTROL MEASURES

#### **NOTE:RAINWATER TANKS**

- 1- RAIN WATER TANK CAPACITY AS PER BASIX REQUIREMENTS
- P2- THE SYSTEM TO BE DESIGNED WITH THE FOLLOWING GUIDELINES
- P A "FIRST FLUSH" DIVERSION TO REMOVE ROOF CONTAMINANTS
  P ADEQUATE SCREENING TO PREVENT MOSQUITO BREEDING AND
- ENTRY OF ANIMALS OF FOREIGN MATTER
- P3- TANKS TO BE PLUMBED TO TOP UP FROM THE POTABLE WATER SUPPLY
- DURING DRY PERIODS WHEN THE TANKS ARE 80% EMPTY.
- P4- NO DIRECT CROSS CONNECTION WITH THE SYDNEY WATER POTABLE SUPPLY [
- AND AIR GAS MAINTAINED ABOVE THE OVERFLOW IN THE TANK.
- P5- A SING TO BE INSTALLED STATING "NOT FOR HUMAN CONSUMPTION. P6- RAINWATER TANK TO BE CONNECTED AS PER BASIX REQUIREMENTS
- P7- OVERFLOW FROM THE TANK SHALL BE PIPED TO THE DRAINAGE SYSTEM.

TITLE:

SEDIMENT CONTROL

### STORMWATER-DRAINAGE PLAN

					CLIENT: Mr & Mrs Phillip	
					PROJECT:	
Α	21/06/22	L.L.F.	G.BOTROS	DA SUBMIT	TWO STOREY-DUAL OCCUPANO	
REV	DATE	DRAWN	CHEKD	DESCRIPTION	L31, 14 Davies Road, Padstow	

## **GHALY BOTROS**

Structural Civil Engineers

242 The River Road Revesby 2212 NSW TEL: (02) 9792 4899

FAX: (02) 9792 4899 MOB: 0414 979377 E-MAIL: gbcon@msn.com

DATE: 17/06/22	SCALE: AS SHOWN		
DESIGN BY:	CHECKED BY: G-BOTROS		
DRAWN BY: L.L.F.	APPROVED:		
SHEET NO. SHEET 3 of 3	DWNG NO. 186/22	REV. A	